NORTH DUNN STREET SIDEWALK CONNECTION


INDEX OF DRAWINGS


- TITLE SHEET, INDEX
- GENERAL NOTES, LEGEND, UTILITY DATA, SUMMARY 2 OF QUANTITIES TABLE, STRUCTURE DATA TABLE
- MISCELLANEOUS DETAILS 3
- PLAN AND PROFILE 4




8720 Castle Creek Pkwy E Dr, Suite 400, Indianapolis, IN 46250 https://eticagroup.com


CITY OF BLOOMINGTON ENGINEERING DEPARTMENT

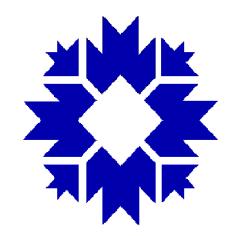

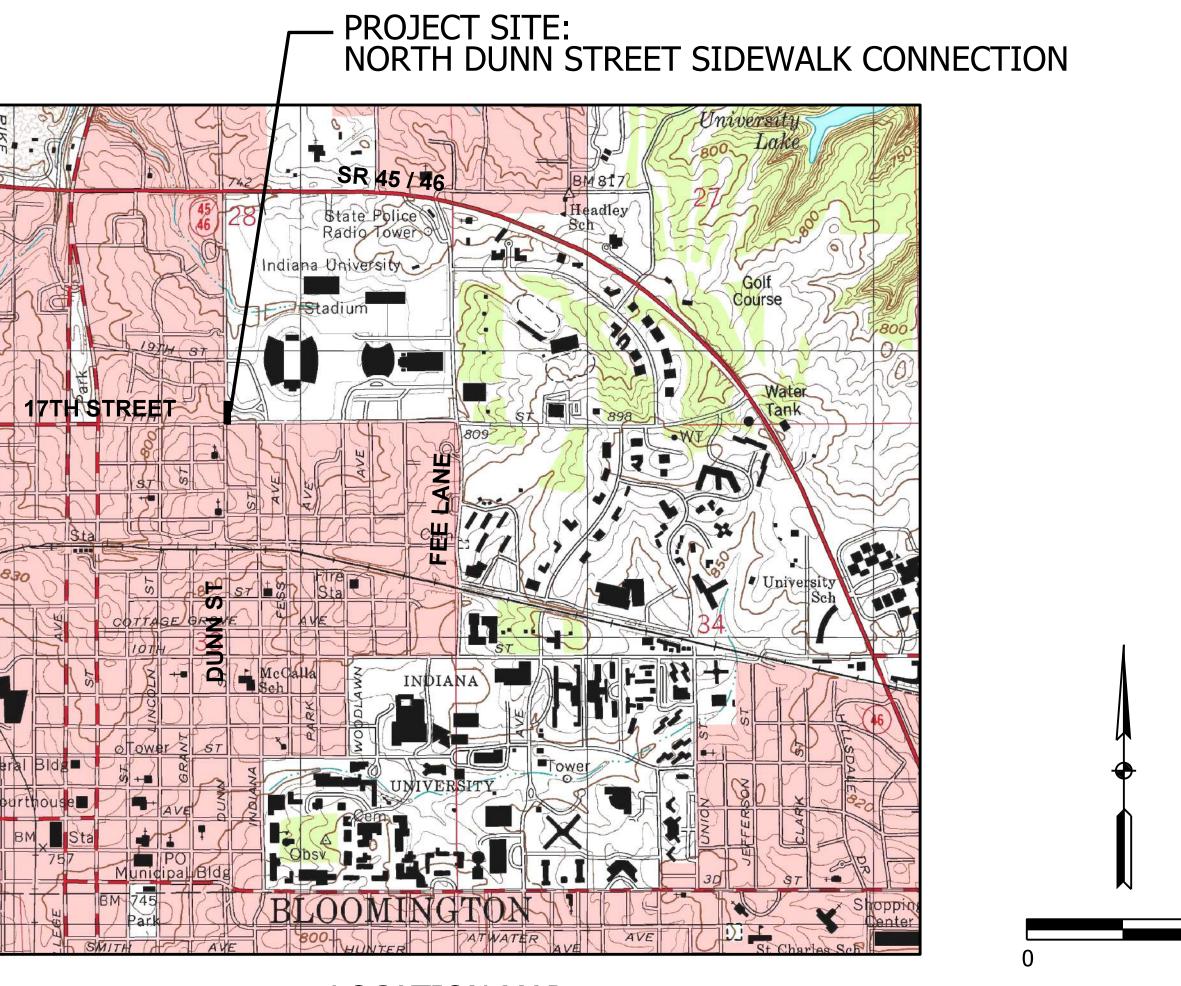

LOCATION MAP INDIANA UNIVERSITY BLOOMINGTON, INDIANA

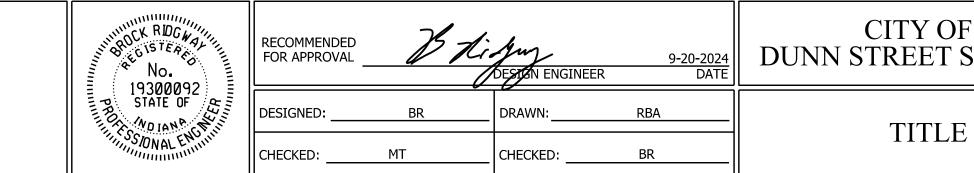

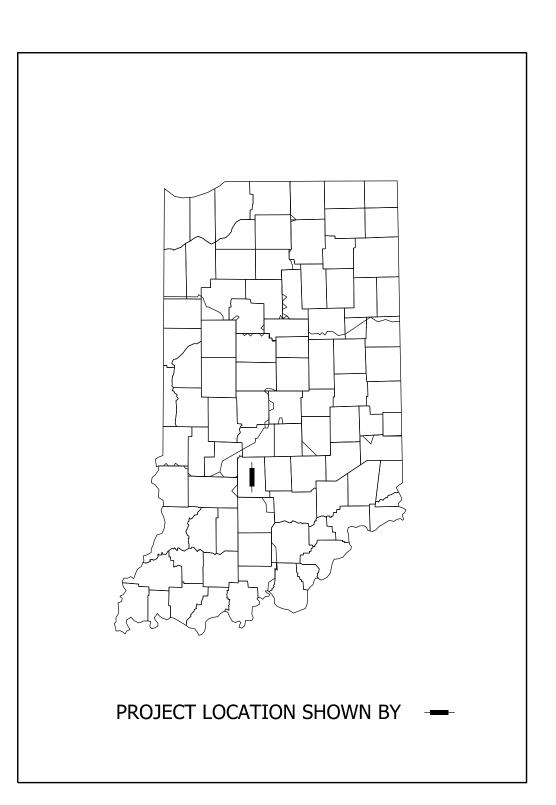

2000'

INDIANA DEPARTMENT OF TRANSPORTATION STANDARD SPECIFICATIONS CURRENT EDITION TO BE USED WITH THESE PLANS.

	BRI	DGE FIL	F I		
IORIZONTAL SCALE AS NOTED	N/A				
VERTICAL SCALE	ETICA PROJECT				
N/A	240039				
SURVEY BOOK	S	HEETS			
N/A	1	of	4		
CONTRACT					
N/A					
	VERTICAL SCALE N/A SURVEY BOOK N/A CONTRACT	VERTICAL SCALE ETICA N/A 2 SURVEY BOOK S N/A 1 CONTRACT	VERTICAL SCALE ETICA PROJE N/A 240039 SURVEY BOOK SHEETS N/A 1 of CONTRACT		

UTILITIES ELECTRIC:

DUKE ENERGY SITE MEETS AND COORDINATION: dei-dline-coord@duke-energy.com ATTN: CINDY ROWLAND Cindy.rowland@duke-energy.com 317-776-5341 CHRISTINA GIROD

Christina.girod@duke-energy.com 317-273-9596 LIGHTING CONTACT: ATTN: CRAIG BARKER

Craig.barker@duke-energy.com 317-452-3743

GAS:

<u>CENTERPOINT ENERGY (FORMER VECTREN)</u> ATTN: ARIEL THOMAS athomas@centerpointenergy.com 812-272-2438

STORM/SANITARY/WATER: CITY OF BLOOMINGTON UTILITIES -MUNICIPAL UTILITY ATTN: JANE FLEIG, P.E. Fleigj@bloomington.in.gov 812-349-3631 600 E. MILLER DRIVE BLOOMINGTON, IN 47404

TELECOMMUNICATIONS:

AT&T ATTN: TOD MOORE Tm1925@att.com O: 812-334-4718; CELL: 812-606-2957 4517 INDIANA BELL COURT BLOOMINGTON, IN 47408

BLOOMINGTON DIGITAL UNDERGROUND ATTN: ROB CRONK Rob.cronk@bloomington.in.gov 812-349-3454 401 N. MORTON STREET SUITE 160 SUITE 160 BLOOMINGTON, IN 47404

COMCAST ATTN: RICHARD MILLER Richard Miller3@comcast.com 317-945-2670 Steve McArtor Steve mcartor@cable.comcast.com 812-360-3090

SCOTT TEMPLETON Scott Templeton@comcast.com 812-822-3262 1600 W. VERNAL PIKE BLOOMINGTON, IN 47404

LUMEN (FORMER LEVEL 3 AND CENTURY LINK) ATTN: GARY CARVER Gary.carver@lumen.com 318-388-9775 ATTN: JOHN UNVERFERTH 419-771-8332 419-771-8332 4625 W. 86TH STREET

INDIANAPOLIS, IN 46268

TELECOMMUNICATIONS (CONT.): SMITHVILLE COMMUNICATIONS ATTN: JOE BRYNIARSKI Joe.bryniarski@smithville.com 812-320-9317 1600 W. TEMPERANCE STREET ELLETTSVILLE, IN 47429-0729

<u>US SIGNAL</u> ATTN: CHARLIE OLSZEWSKI colszewski@ussignal.com 616-988-7194 201 IONIA AVE, SW

GRAND RAPIDS, MI 49503 WINDSTREAM (FORMER KDL) ATTN: MARK MILLS Mark.mills@windstream.com

217-460-0002 5020 SMYTHE DRIVE EVANSVILLE, IN 47715

ZAYO ATTN: WAYLON HIGGINS Waylon.higgin@zayo.com 765-341-1199 9209 CASTLEGATE DR. INDIANAPOLIS, IN 46256

INDIANA UNIVERSITY IU-OWNED FACILITIES ATTN: PHIL NICHOLS / SCOT OSBORN pdnichol@indiana.edu scosborn@iu.edu 812-856-2789

<u>IU LOCATES:</u> ATTN: DONNIE GOODWIN drgoodwi@indiana.edu 812-856-1147

GENERAL NOTES
<u>USE OF INDOT STANDARD SPECIFICATIONS:</u> UNLESS OTHERWISE PROVIDED IN THESE PLANS OR THE TECHNICAL SPECIFICATIONS, MATERIALS AND WORKMANSHIP OF THE WORK SHALL BE AS REQUIRED BY THE CURRENT EDITION OF THE INDOT STANDARD SPECIFICATIONS, EXCEPT FOR STORM SEWER WORK, WHICH WILL BE PER CBU SPECIFICATIONS.
<u>USE OF PROPERTY:</u> NO MATERIALS OR EQUIPMENT SHALL BE STORED IN A LOCATION OR MANNER WHICH PRESENTS A HAZARD TO THE PUBLIC OR THE ENVIRONMENT. THE SAFEGUARD OF MATERIALS REMAINING IN THESE AREAS IS THE SOLE RESPONSIBILITY OF THE CONTRACTOR.
COORDINATION OF DRAWINGS, TECHNICAL SPECIFICATIONS AND STANDARD SPECIFICATIONS: THE CONTRACT DOCUMENTS WHICH ARE LISTED IN THE AGREEMENT ARE INTENDED TO BE COMPLEMENTARY AND TO DESCRIBE AND PROVIDE FOR COMPLETE WORK. A REQUIREMENT APPEARING IN ONE IS BINDING AS THOUGH OCCURRING IN ALL. IN CASE OF DISCREPANCY, THE FOLLOWING ORDER OF PRECEDENCE WILL APPLY: 1. CONSTRUCTION AGREEMENT, 2. INSTRUCTION AGREEMENT, 3. SUPPLEMENTARY GENERAL CONDITIONS, 4. PERMITS ISSUED BY FED/STATE/LOCAL AGENCIES 5. TECHNICAL SPECIFICATIONS, 6. GENERAL CONDITIONS, 7. PROJECT DRAWINGS, 8. STANDARD SPECIFICATIONS AS PUBLISHED BY THE INDIANA DEPARTMENT OF TRANSPORTATION, CURRENT EDITION.
<u>PRESENCE OF UTILITIES:</u> EXISTING UTILITIES SHOWN ON PLANS ARE APPROXIMATED IN ACCORDANCE WITH AVAILABLE RECORDS, LOCATOR'S MARKINGS, AND PHYSICAL EVIDENCE. OTHER UTILITIES MAY ALSO BE PRESENT. EXACT LOCATIONS AND ELEVATIONS ARE TO BE DETERMINED BY CONTRACTOR.
UTILITY LOCATIONS: CONTRACTOR IS REQUIRED BY LAW TO NOTIFY INDIANA UNDERGROUND LOCATION SERVICE AT LEAST TWO WORKING DAYS PRIOR TO COMMENCING ANY EXCAVATION WORK. CONTACT NUMBER IS 811. OTHER LOCAL UTILITIES MAY NOT BE SUBSCRIBERS AND MUST BE CONTACTED INDIVIDUALLY FOR LOCATE REQUESTS.
INCIDENTAL WORK: ALL WORK SHOWN OR SPECIFIED IN THE CONTRACT DOCUMENTS AND OTHER WORK WHICH MAY BE INCIDENTAL TO THE DENOTED WORK SHALL BE CONSIDERED TO BE INCLUDED IN THE TOTAL CONTRACT LUMP SUM PRICE.
<u>PERMITS:</u> CONTRACTOR SHALL BE RESPONSIBLE FOR OBTAINING ANY LOCAL PERMITS TO COMPLETE THE WORK AS SHOWN, PERMITS ARE REQUIRED WHEN A RESTRICTION IS TO BE USED FOR CITY STREETS. CONTRACTOR WILL BE REQUIRED TO COMPLETE THE APPLICATION OF SUCH PERMITS WHERE THE PERMIT COORDINATION OR APPLICATION IS NOT YET COMPLETE AT THE TIME OF BIDDING.
STAKING: CONTRACTOR SHALL BE RESPONSIBLE FOR ALL STAKING.
UTILITY LOCATION AND PROTECTION: CONTRACTOR WILL BE RESPONSIBLE FOR CALLING IN LOCATES, VERIFYING UTILITY/DEPTHS INCLUDING POTHOLING AS WARRANTED, AND PROTECTING EXISTING UTILITIES IN PLACE. CONTACT ENGINEER IF ADJUSTMENTS ARE NEEDED TO DESIGN TO AVOID A FOUND UTILITY.

LEGEND

(3)	PCCP FOR CLASS III DRIVES, 9" ON 6" COMPACTED AGGREGATE NO. 53s, ON COMPACTED SUBGRADE	TS	TURNING SPACE AREA - NOT TO EXCEED 2% IN ANY DIRECTION CROSS SLOPE DIRECTION		Ø	UTILITY POLE
(CL)	CONSTRUCTION LIMITS		DETECTABLE WARNINGS (STEEL PLATES ONLY)		Ø	
F	CONCRETE SIDEWALK, 4" ON 4" COMPACTED AGGREGATE NO. 53s	•	INDOT STANDARD DRUM		\bigcirc	SINGLE ARM CANTILEVER SIGN
(F6)	6" CONCRETE SIDEWALK, REINFORCED ON	\square	BARRICADE, TYPE III-B		<u> </u>	SINGLE SIGN POST
(K3)	4" COMPACTED AGGREGATE NO. 53s FULL HMA WEDGE AND LEVEL	\rightarrow	TRAFFIC FLOW DIRECTION		$\bigcirc] \rightarrow$	PEDESTRIAN SIGNAL POLE
Ŭ	MILL 1" THEN VARIABLE DEPTH INTERMEDIATE IN MAX 3" LIFTS COVERED WITH 1.5" HMA SURFACE, A	CP	CULVERT PROTECTION		□ FR	FIBER RISER
13	CONCRETE CURB, REINFORCED, 12" WIDE	SF	SILT FENCE		ER	ELECTRIC RISER
15	CONCRETE CURB AND GUTTER	(IP)	INLET PROTECTION		R/W	RIGHT-OF-WAY MARKER
(26)	NURSERY SODDING ON MIN. 4" TOPSOIL		DOUBLE SIGN POST		PB	PULLBOX
(56)	RESET SIGN ON NEW POSTS, TYPE 1		DODLE SIGN TOST		_	
AC	ADJUST CASTING TO GRADE	Q	FIRE HYDRANT		TF	ELECTRICAL BOX
P	PCCP FOR PATCHING, 9"	BØ	BOLLARD - CONCRETE		M PPST	POST
		Ø	UTILITY POLE		CC-TR	TRAFFIC CONTROLLER CABINET
		TR	TRAFFIC SIGNAL MANHOLE	UC		UNDERGROUND CABLE
		() мкg	WARNING MARKER - GAS	— FO — FO -		UNDERGROUND FIBER OPTIC LINE
		\ast	CONIFEROUS TREE			UNDERGROUND ELECTRIC
		E3	DECIDUOUS TREE	========st	M =	UNDERGROUND STORM (RAIN) SEWER
		•	BORING LOCATION		·	UNDERGROUND WATER
		\supset	ANCHOR FOR GUY ROPE	GG		UNDERGROUND GAS



E	STIM	ATE	OF	PAV	EME	NT A	ND M	ISCE	LLAN	EOUS	G QUA	NTIT	ES TA	ABLE	
	REINFORCING				AGG.	ACTED BASE			ΓH, B				AS NEEDED	T TO	SIGNS
	REINF	.4	ы С	S, 9"	#5	3s	6		DEPTH,					snra	POSTS
	6", INCL. F	SIDEWALK,	R, TYPE	PCCP FOR APPROACHES,	SdV	SUBGRADE PE II)	HING,	E.	PARTIAL	R R) LEVEL	NG	NURSERY Incl. TOPSOIL	OR METER, ADJUST TO GRADE	.
		SIDEV	GUTTER,	PR0/	& RAMPS	SUBG PE II)	FOR PATCHING	TACK COAT		ADHESIVE	E AND	GRADING	cl. TC	A MET	Ч Т ҮР
	SIDEWALK,		AND G	DR AF		(AKA - { ENT TYF	FOR	TACK	FOR PATHCING,	NTA	HMA WEDGE	LINEAR G	RY In		IIM
	SIDE	CONCRETE	CURB A	CP F(SIDEWALKS	ES (A TMEN	РССР		R PAT	JOINT	MAV	LIN	URSE	, VAL	CATE
		ပ	CU	ЪС		K DRIVES (AKA - SUBC TREATMENT TYPE II)	–		A FOF				NG, N	CASTING, VALVE	SIGN, RELOCATE WITH TYPE
	CONCRETE				UNDER	UNDER 1			АМН				SODDING,	CA	SIGN,
	6"	4"			4"	6"	12"								
	SYS	SYS	LFT	SYS	SYS	SYS	SYS	SYS	SYS	LFT	SYS	LFT	SYS	EACH	EA
All Project	256	24	140	73	76	282	282 43 43 43 130 82 300 570		43 130 82 300 570		2	2			
Subtotal>	256	24	140	73	76	282	43	43	43	130	82	300	570	2	2
Subtotal Units>	SYS	SYS	LFT	SYS	SYS	SYS	SYS	SYS	SYS	LFT	SYS	LFT	SYS	EA	EA
Pay Total>	256	24	140	73		bine>	43	43	4	130	21	300	570	2	2
Pay Units>	SYS	SYS	LFT	SYS	109	TONS	SYS	SYS	TONS	LFT	TON	LFT	SYS	EA	EA

Signs are to be mounted 7' from top of anchor base to bottom of sign per City standards. All removal tasks are to be paid as CLEARING

SURVEY CONTROL TABLE (From USI project # 2020-0025)											
POINT NO.	NORTHING	EASTING	ELEVATION	POINT DESCRIPTION							
100	201623.3250	779335.5470	803.28	5/8" REBAR W/ USI CONTROL CAP							
101	201963.9120	779431.9110	778.97	5/8" REBAR W/ USI CONTROL CAP							

	STRUCTURE DATA													
		_					FLOV	LINE						
STRUCTURE NUMBER	PIPE SIZE	PIPE MATERIAL	MANHOLE, CATCH BASIN, INLET, OR SPECIALTY STRUCTURE	LENGTH	SLOPE	COVER	UP STREAM	DOWN STREAM	CASTING	CONNECT TO STR.	BEDDING BACKFILL #11 OR #12 CRUSHED AGGREGATE	PRIMARY BACKFILL #11 OR #12 CRUSHED AGGREGATE	EROSION CONTROL - INLET PROTECT REQUIRED	NOTES
	in			ft	%	ft	ELEV.	ELEV.	ELEV.		CYD	CYD	EA	
11	24	HDPE	Manhole D4	156	7.0	3.0	798.08	787.10	803.04	13	6.4	78.0		
12	12	HDPE	Inlet C15	15	16+/-	1.5	792.50	790.00	793.87	13	0.4	3.1	1	Adjust Pipe depth as needed to avoid buried FO.
13	NA	NA	Manhole D4	0	NA	NA	NA	~786.7	792.00	Exist	0.0	0.0	1	Connect to Ex. Elliptical pipe 30"x19"
13A	6	PVC	Pipe Stub	6	Field Det	Field Det.	Exist	~787.11	NA	13	0.2	0.5		Connect to Ex. Small Drain Pipe
											7	82	2	
OTES:											CYD	CYD	EA	


1 All work on structures shall be per CBU specifications.

2 Contractor shall be required to schedule a Preconstruction meeting with City of Bloomington Utilities. 3 All elevations of pipe inverts are to be verified in the field by the contractor prior to ordering precast structures.

OU OU OVERHEAD UTILITY

No. 19300092	RECOMMENDED FOR APPROVAL		DESTON ENGINEER	<u>9-20-2024</u> DATE	CITY O DUNN STREET
STATE OF	DESIGNED:	BR	DRAWN:	RBA	GENERA
SIONAL ENUMIN	CHECKED:	MT	CHECKED:	BR	UT SUMMARY C

	HORIZONTAL SCALE	BR	IDGE F	FILE	
F BLOOMINGTON	N/A		N/A		
SIDEWALK CONNECTION	VERTICAL SCALE	ETICA PROJECT			
	N/A	240039			
L NOTES, LEGEND,	SURVEY BOOK	9	SHEET	S	
	N/A	2	of	4	
TILITY DATA,	CONTRACT				
OF QUANTITIES TABLE	N/A				

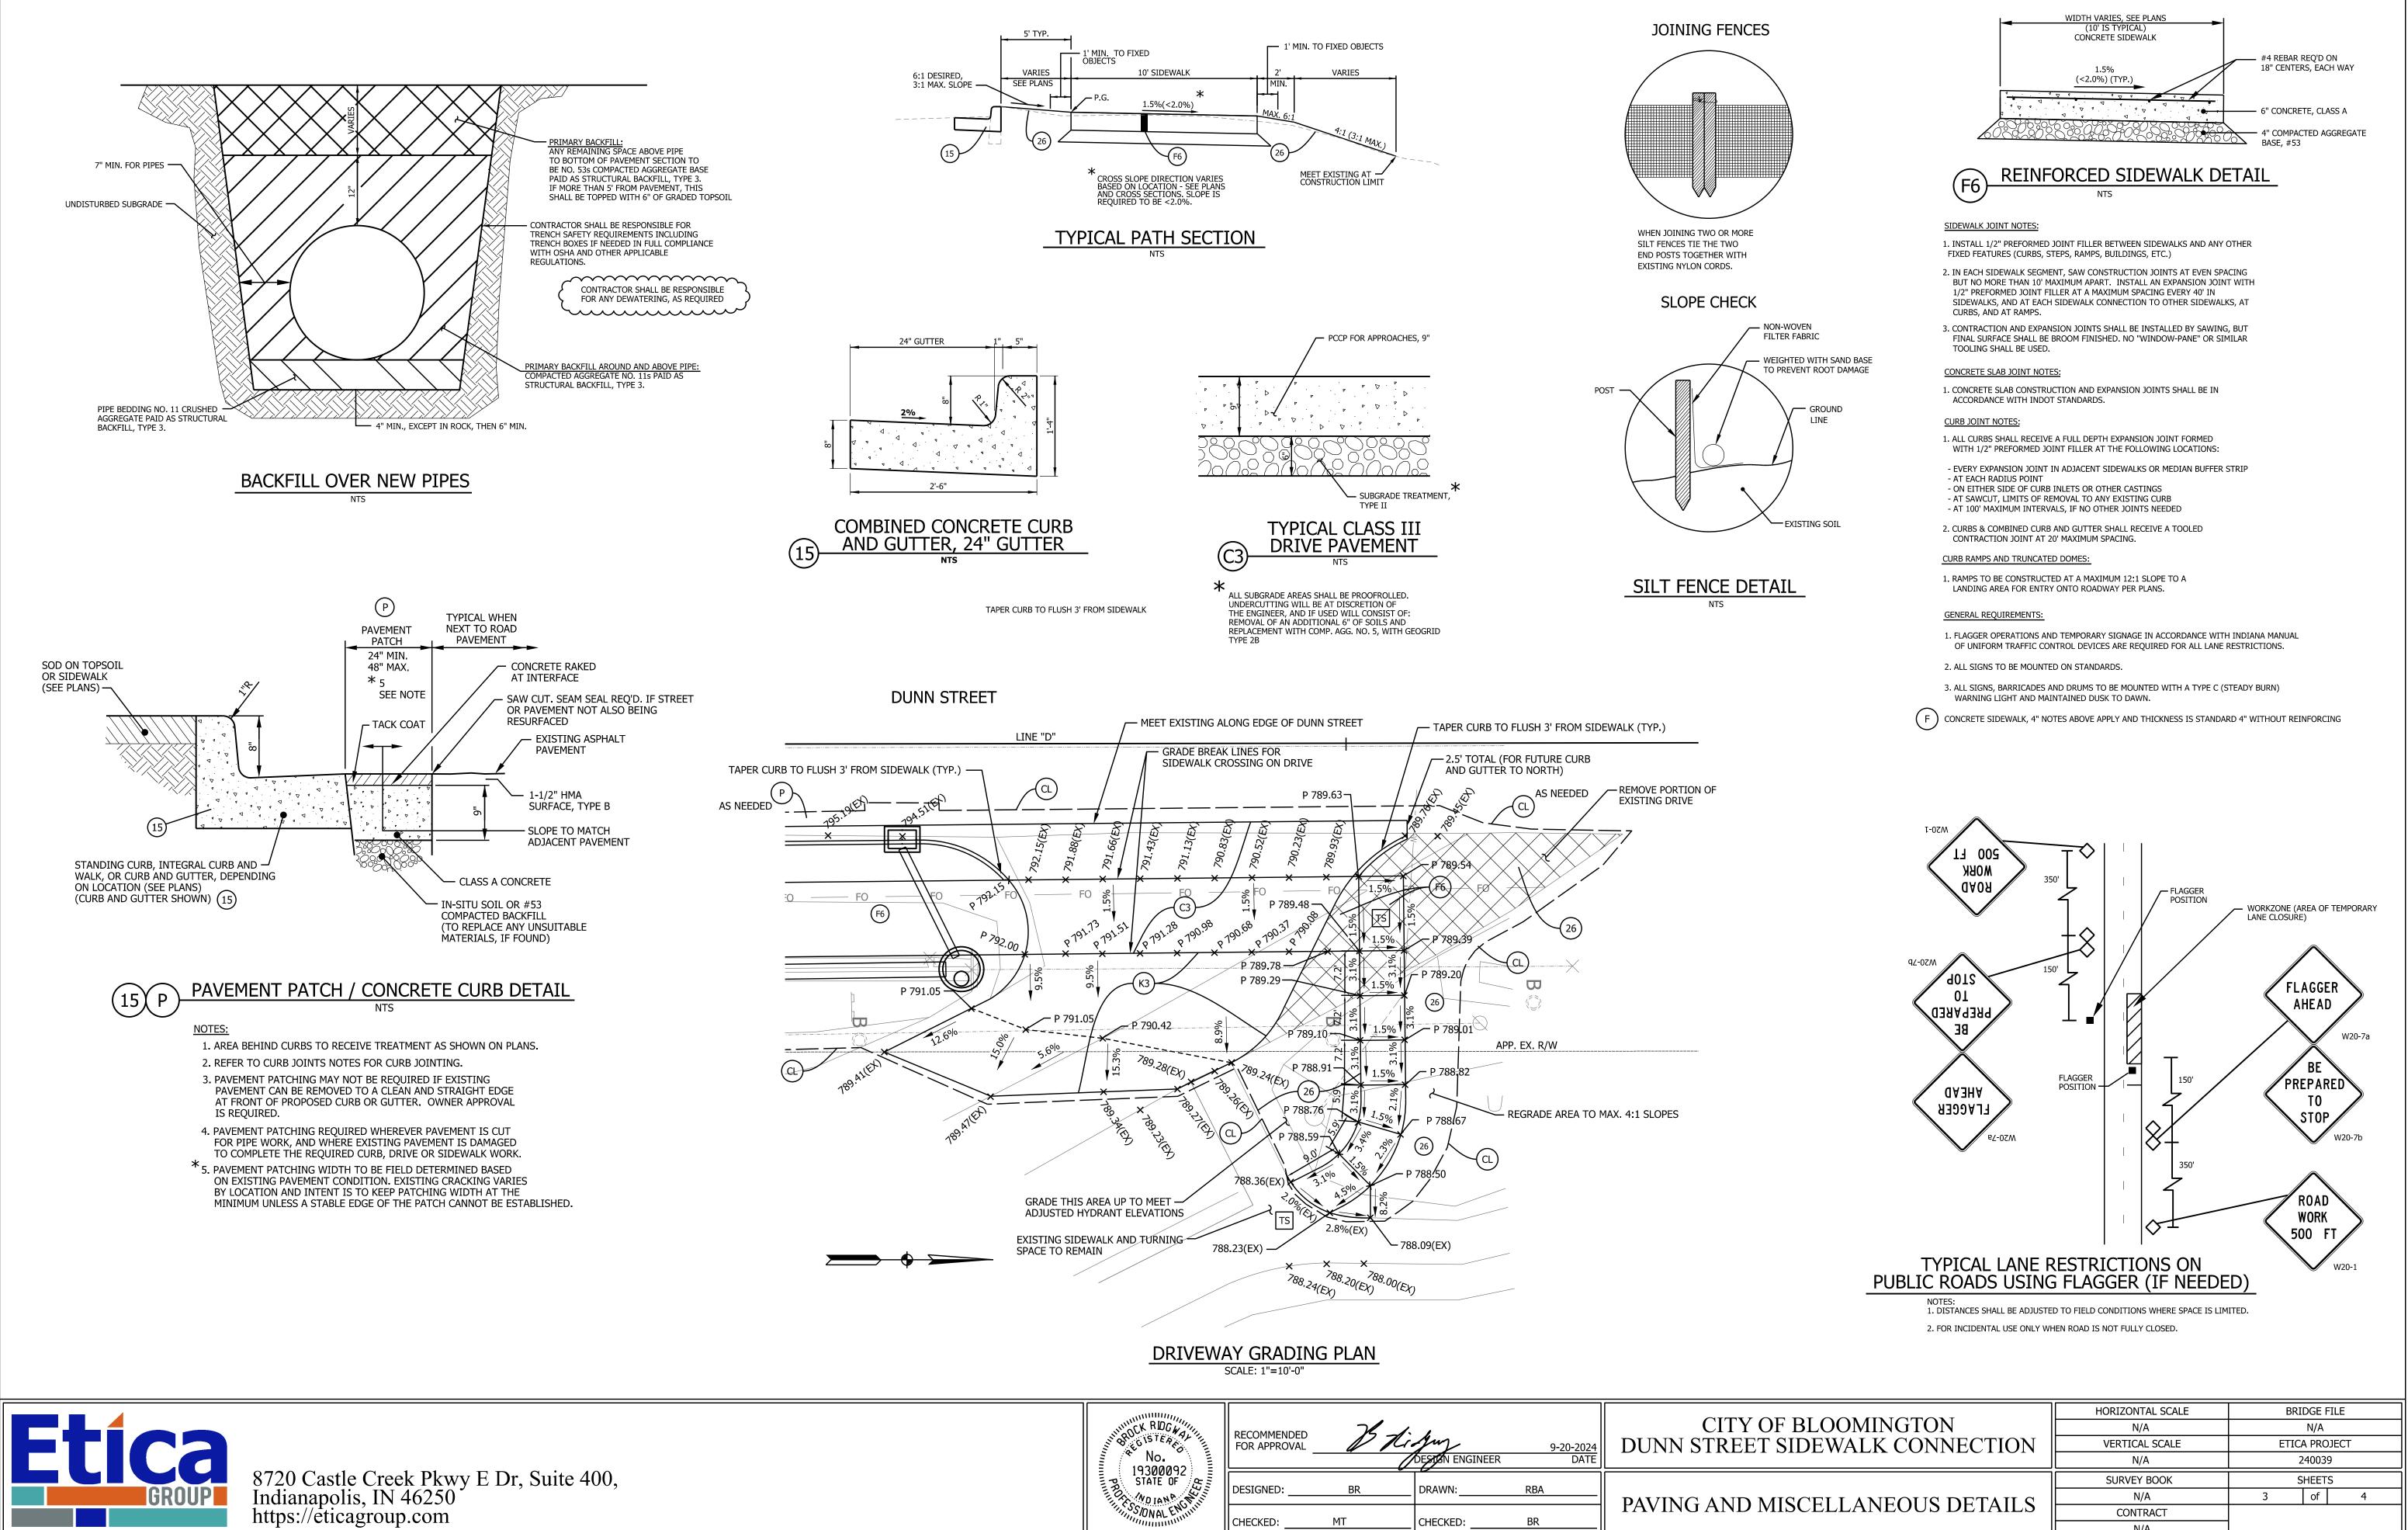

No.	RECOMMENDED FOR APPROVAL		Juj DESTAN ENGINEER	<u>9-20-2024</u> DATE	CITY OF DUNN STREET S
THE STATE OF	DESIGNED:	BR	DRAWN:	RBA	PAVING AND MIS
I JONAL EN INT	CHECKED:	MT	CHECKED:	BR	


ISCELLANEOUS DETAILS

N/A

of

4

3

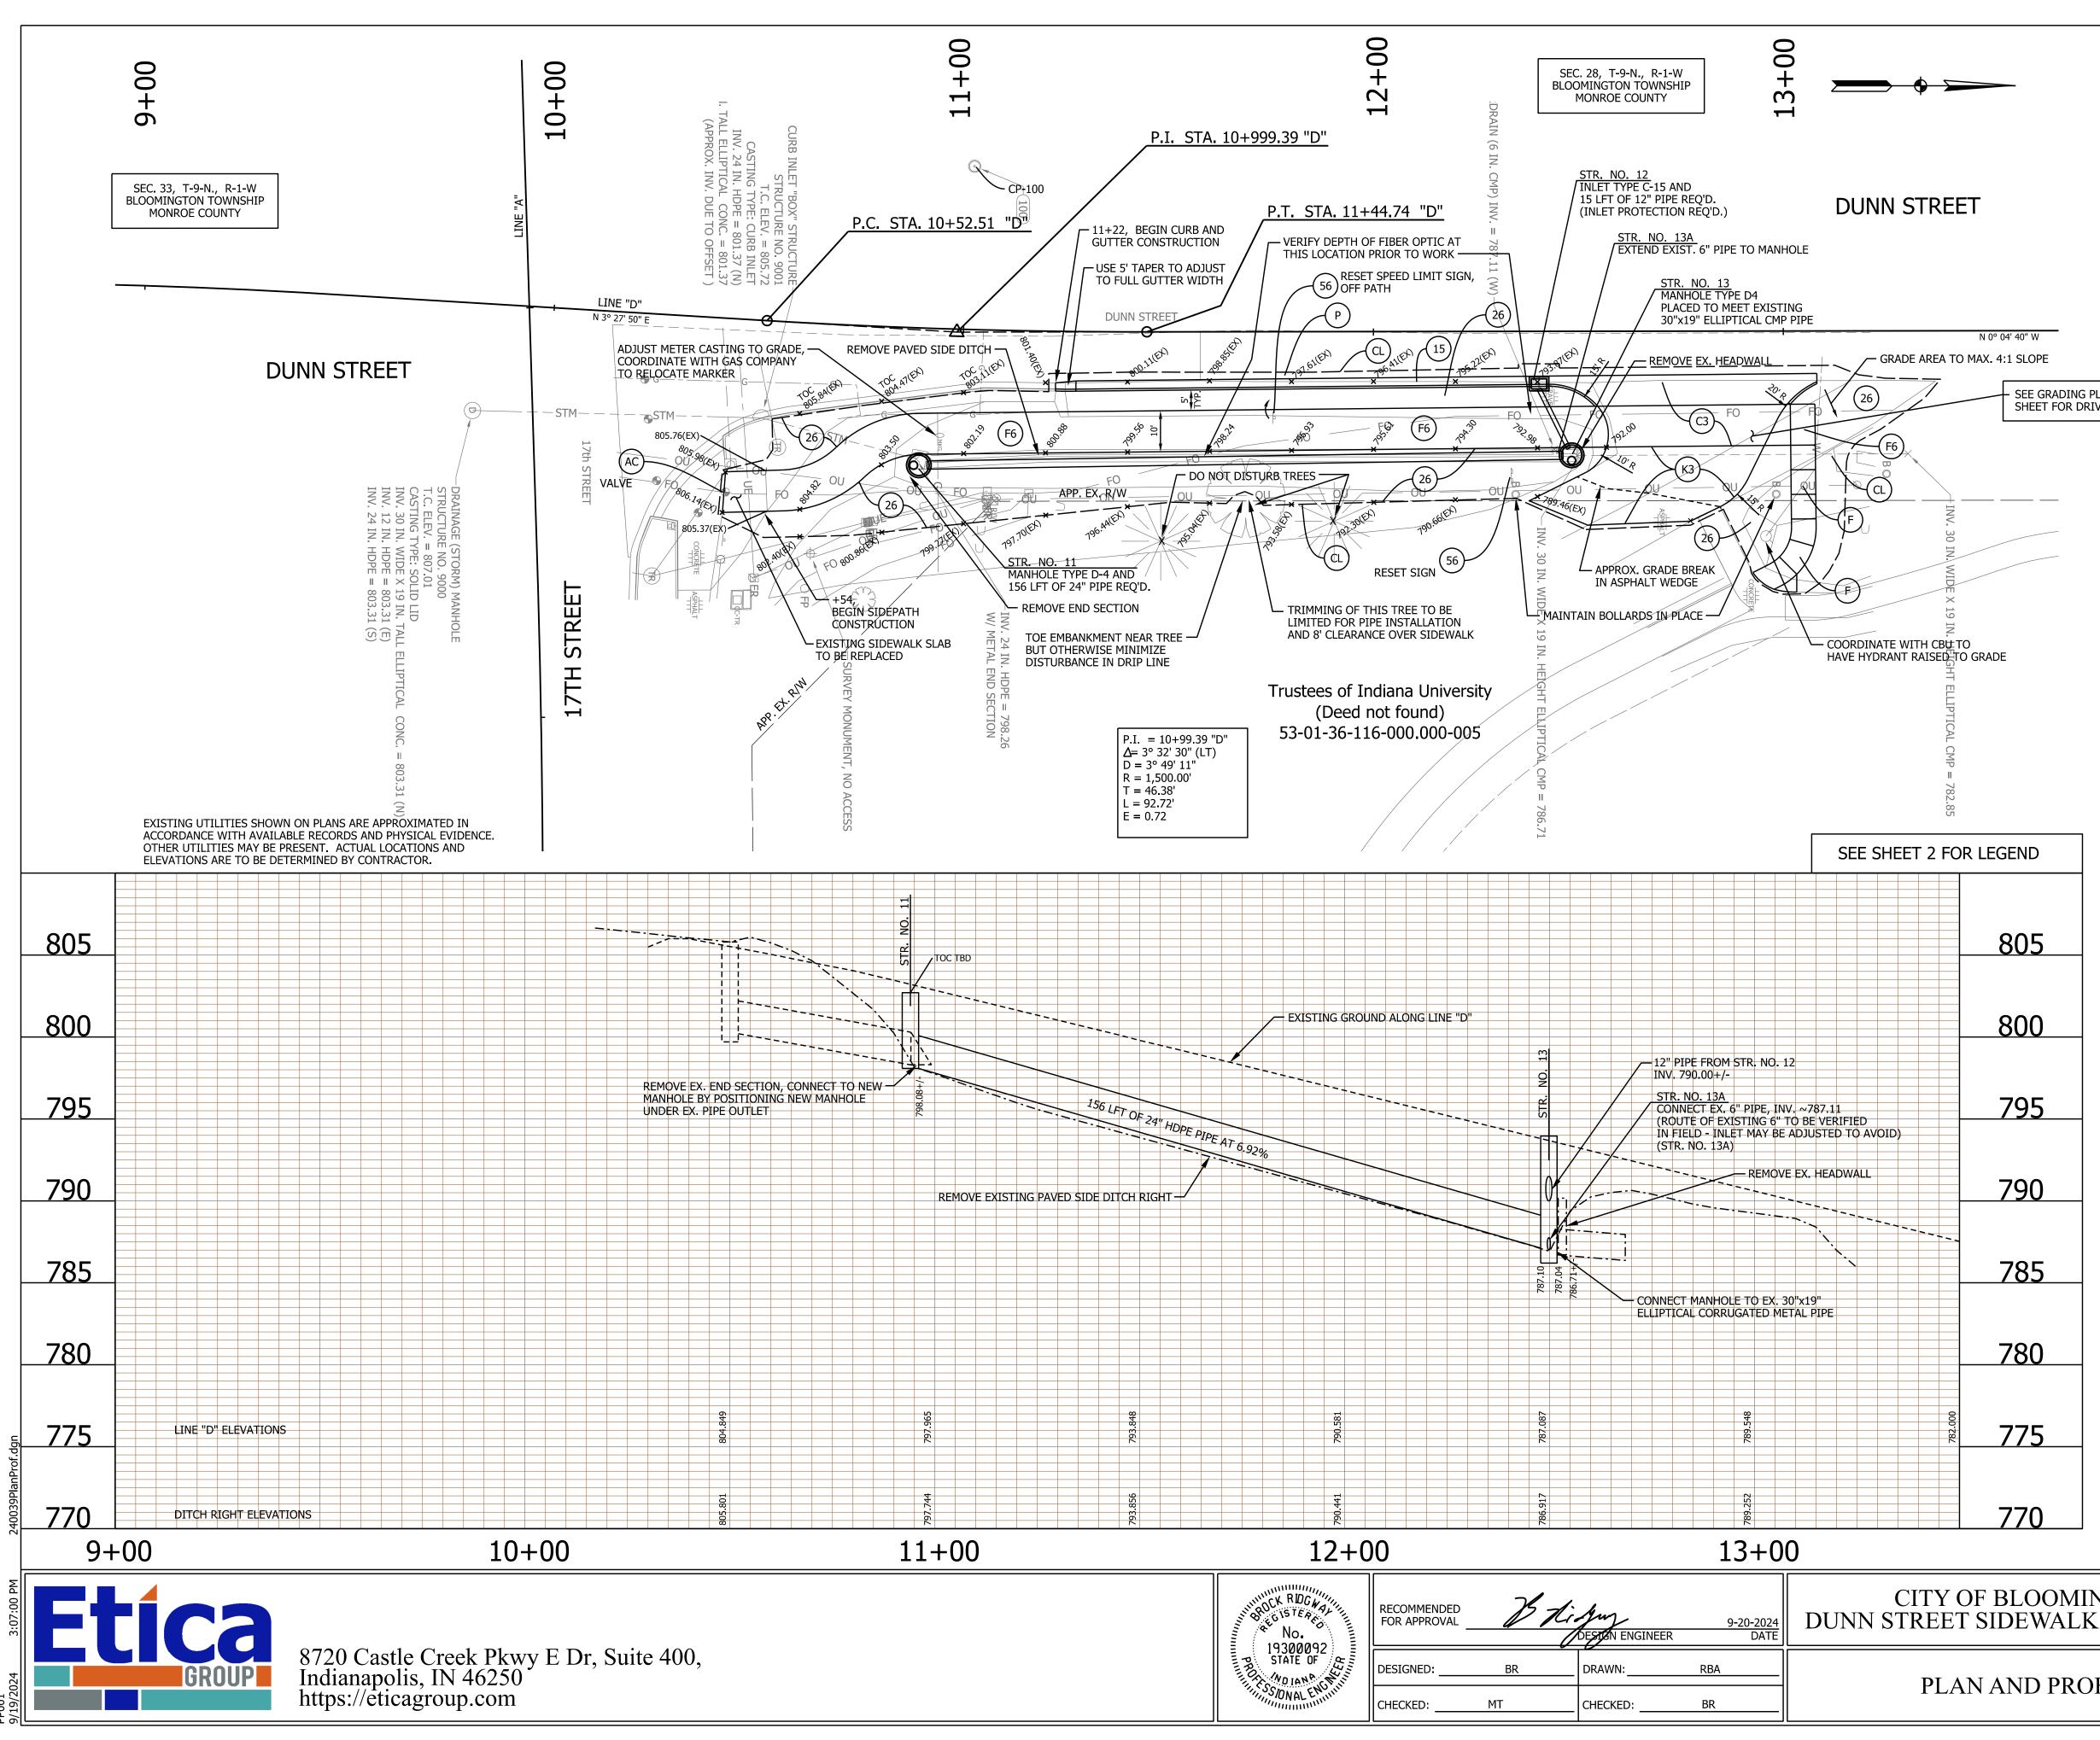

F BLOOMINGTON	HORIZONTAL SCALE 1" = 20'-0"	BRIDGE FILE N/A				
SIDEWALK CONNECTION	VERTICAL SCALE	ETICA PROJECT				
SIDE WALK CONNECTION	1" = 5'-0"	240039				
	SURVEY BOOK	S	HEET	s		
	N/A	4	of	Х		
N AND PROFILE	CONTRACT	· · ·				
	N/A					

SEE GRADING PLAN ON PREVIOUS SHEET FOR DRIVEWAY PAVING

DRIVE CLOSURE TO REQUIRE: 120' OF TYPE III-B BARRICADES AND 3 EA. "ROAD CLOSURE", R11-2 (2 EA. FOR DUNN STREET SIDE)